
#### **GENERAL NOTES:**

- THIS PRODUCT HAS BEEN TESTED, ANALYZED & APPROVED FOR DESIGN PRESSURES NOT TO EXCEED THOSE SHOWN IN THE "ALLOWABLE DESIGN PRESSURE TABLE(S)".
- 2. OPENINGS, BUCKING & BUCKING FASTENERS MUST BE PROPERLY DESIGNED & INSTALLED TO TRANSFER WIND LOADS TO THE STRUCTURE.
- 3. ALL HARDWARE & FASTENERS SHALL BE IN ACCORDANCE WITH THESE DRAWINGS & SHALL NOT VARY UNLESS SPECIFICALLY MENTIONED ON THE DRAWINGS. SPECIFIED ANCHOR EMBED TO BASE MATERIAL SHALL BE BEYOND WALL FINISH OR STUCCO.
- 4. This product has been designed in accordance with and meets the requirements of the FLORIDA BUILDING CODE (FBC) INCLUDING HIGH VELOCITY HURRICANE ZONES (HVHZ) & IS LARGE MISSILE
- IMPACT SHUTTERS ARE NOT REQUIRED WITH THIS PRODUCT.
- ALL ANCHORS SECURING PRODUCT FRAMES TO PRESSURE TREATED BUCKS OR WOOD FRAMING SHALL BE CAPABLE OF RESISTING CORROSION CAUSED BY THE PRESSURE TREATING CHEMICALS IN THE WOOD.
- DETERMINE THE POSITIVE & NEGATIVE DESIGN LOADS TO USE WHEN REFERENCING THESE DOCUMENTS IN ACCORDANCE WITH THE GOVERNING CODE AND GOVERNING WIND VELOCITY. FOR WIND LOAD CALCULATIONS IN ACCORDANCE WITH THE FLORIDA BUILDING CODE, A DIRECTIONALITY FACTOR OF Kd = 0.85 MAY BE APPLIED PER THE ASCE-7 STANDARD.
- 8. MATERIALS, INCLUDING BUT NOT LIMITED TO STEEL SCREWS, THAT COME INTO CONTACT WITH OTHER DISSIMILAR MATERIALS SHALL MEET THE REQUIREMENTS OF FLORIDA BUILDING CODE.
- 9. TO THE BEST OF OUR KNOWLEDGE, THE PRODUCT SHOWN HEREIN IS QUALITY ASSURED BY A FLORIDA STATE APPROVED CERTIFICATION/QA ENTITY & SHALL BE LABELED IN ACCORDANCE WITH THE FBC AND THE FLORIDA DEPARTMENT OF BUSINÉSS & PROFESSIONAL REGULATION SPECIFICATIONS. THESE DRAWINGS SHOW ALL APPLICABLE ELEVATION, COMBINATION, INSTALLATION & COMPARATIVE ANALYSIS CONDITIONS AS DETERMINED THROUGH TESTING & ENGINEERING RATIONAL ANALYSIS. PRODUCT ASSEMBLY SHALL BE IN ACCORDANCE WITH THESE DRAWINGS, THE MANUFACTURER'S QUALITY ASSURANCE SPECIFICATIONS & TESTING REPORTS
- 10. CERTIFICATION OF THIS PRODUCT SHALL BE CONSIDERED VOID IF IT IS INSTALLED WITHOUT A BUILDING PERMIT FROM THE APPLICABLE LOCAL BUILDING DEPARTMENT OR IF IT IS INSTALLED BY ANYONE OTHER THAN A LICENSED CONTRACTOR EXPERIENCED WITH INSTALLATIONS OF THIS TYPE OF PRODUCT.

### CORNER & FRAME END CONSTRUCTION FOR SHEET 1 ELEVATIONS:

FRAME HEAD CORNER: HEAD IS SQUARE CUT, BUTTED TO SIDE, FASTENED WITH THREE (3) NO. 12 X 1" S.S. PHTFS FASTENERS THROUGH THE SIDE MEMBER INTO THE HEAD MEMBER SCREW SPLINES & SEALED WITH SILICONE. FRAME SILL CORNER: SILL IS SQUARE CUT, BUTTED TO SIDE, SECURED TO THE SIDE MEMBER USING A PIVOT ASSEMBLY OR STEEL CLIP, FASTENED WITH THREE (3) NO. 12-24 X 3/8" FHMS AT THE FRAME & TWO (2) NO. 12-24 X 3/8" FHMS AT THE SILL, & SEALED WITH SILICONE. DOOR PANEL CORNERS: VERTICAL STILES RUN THROUGH AND ARE SECURED TO THE RAILS AT THE TOP & BOTTOM WITH 1/4" THICK EXTRUDED CHANNELS. EACH CHANNEL IS FASTENED TO THE STILE & RAIL WITH 1/4-20 X 3/4" PHMS & 3/16" THICK STEEL NUT PLATES. THE INTERSECTION OF EACH CORNER JOINT WAS WELDED WITH A 1/2" DIA. PLUG WELD AND A 1 1/8" LONG FILLET WELD AT BOTH WEBS OF THE RAIL

EVALUATION OF THIS PRODUCT IS BASED ON APPLICABLE STANDARDS AND/OR INFORMATION & RESULTS FROM APPLICABLE TEST REPORTS. THE FLORIDA BUILDING CODE VERSION CONSIDERED WITH THIS EVALUATION WAS THAT IN FORCE AT THE TIME OF THE EVALUATION. IN THE EVENT OF CODE VERSION CHANGES/UPDATES OR IN THE EVENT THAT NEW OR ADDITIONAL TESTING IS COMPLETED ON THIS PRODUCT, PRIOR TO STATING CODE COMPLIANCE WITH THE STATE, THE MANUFACTURER SHALL CONFIRM WITH THE EVALUATION ENGINEER OF RECORD THAT EVERYTHING SPECIFIED HERE-IN IS CURRENT WITH ALL CURRENT TESTING, CODES AND APPLICABLE STANDARDS.

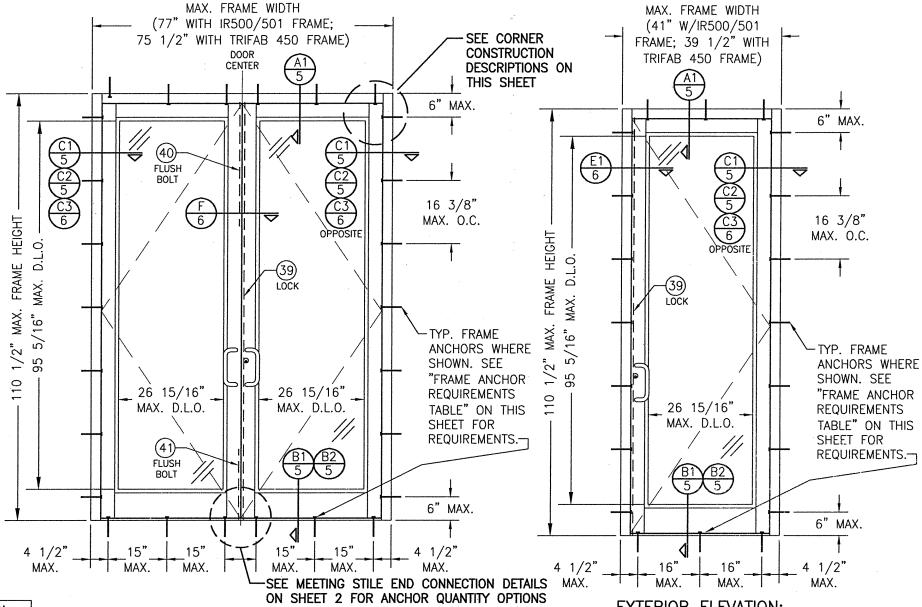

EXTERIOR ELEVATION; DOUBLE DOOR WITH IR-500/501 STORE FRONT FRAMING & STANDARD INSTALLATION

SCALE: 1/2" = 1'-0"

(APPLICABLE WITH ALL HINGE TYPES)

**EXTERIOR ELEVATION:** SINGLE DOOR WITH IR-500/501 STORE FRONT FRAMING & STANDARD INSTALLATION

SCALE: 1/2" = 1'-0"

(APPLICABLE WITH ALL HINGE TYPES)

LOCK OPTION 1 IS SHOWN IN THESE ELEVATIONS. LOCK OPTIONS 2, 3 & 4 ALSO APPLY. SEE ELEVATIONS ON SHEET 2 FOR LOCK OPTIONS 2, 3 & 4.

# ALLOWABLE DESIGN PRESSURE

+/-65 PSF

WATER RATING NOTE: THESE DOOR UNITS ARE NOT APPROVED FOR USE WHERE WATER INFILTRATION RESISTANCE IS REQUIRED BY THE DOOR UNLESS ONE OF THE FOLLOWING APPLIES:

- 1. UNITS ARE INSTALLED IN NON-HABITABLE AREAS WHERE THE UNIT & THE AREA ARE DESIGNED TO ACCEPT WATER INFILTRATION.
- 2. UNITS ARE INSTALLED AT A LOCATION PROTECTED BY A CANOPY OR OVERHANG WHERE-BY THE OVERHANG(OH) RATIO IS EQUAL TO OR MORE
- IF THE DOOR IS INSTALLED IN AN IR-501 SYSTEM THAT HAS THE HEAD JAMB WEATHER SEAL SHOWN IN SECTIONS AT OR G1, HAS A SILL & SILL DAM ASSEMBLY AS SHOWN IN SECTION B2. IF A DOUBLE DOOR, HAS MEETING STILE COVERS AS SHOWN IN SECTION F, USES THE 2 POINT LOCK PART NUMBERS 40 & 41 AT INACTIVE PANELS, USES THE 3-POINT LOCK UNDER PART NUMBER 39 AT ACTIVE PANELS AND USES THE GEAR OR BUTT HINGES UNDER PART NUMBER 36 OR 37.

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SS, GA 30092
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DOORS

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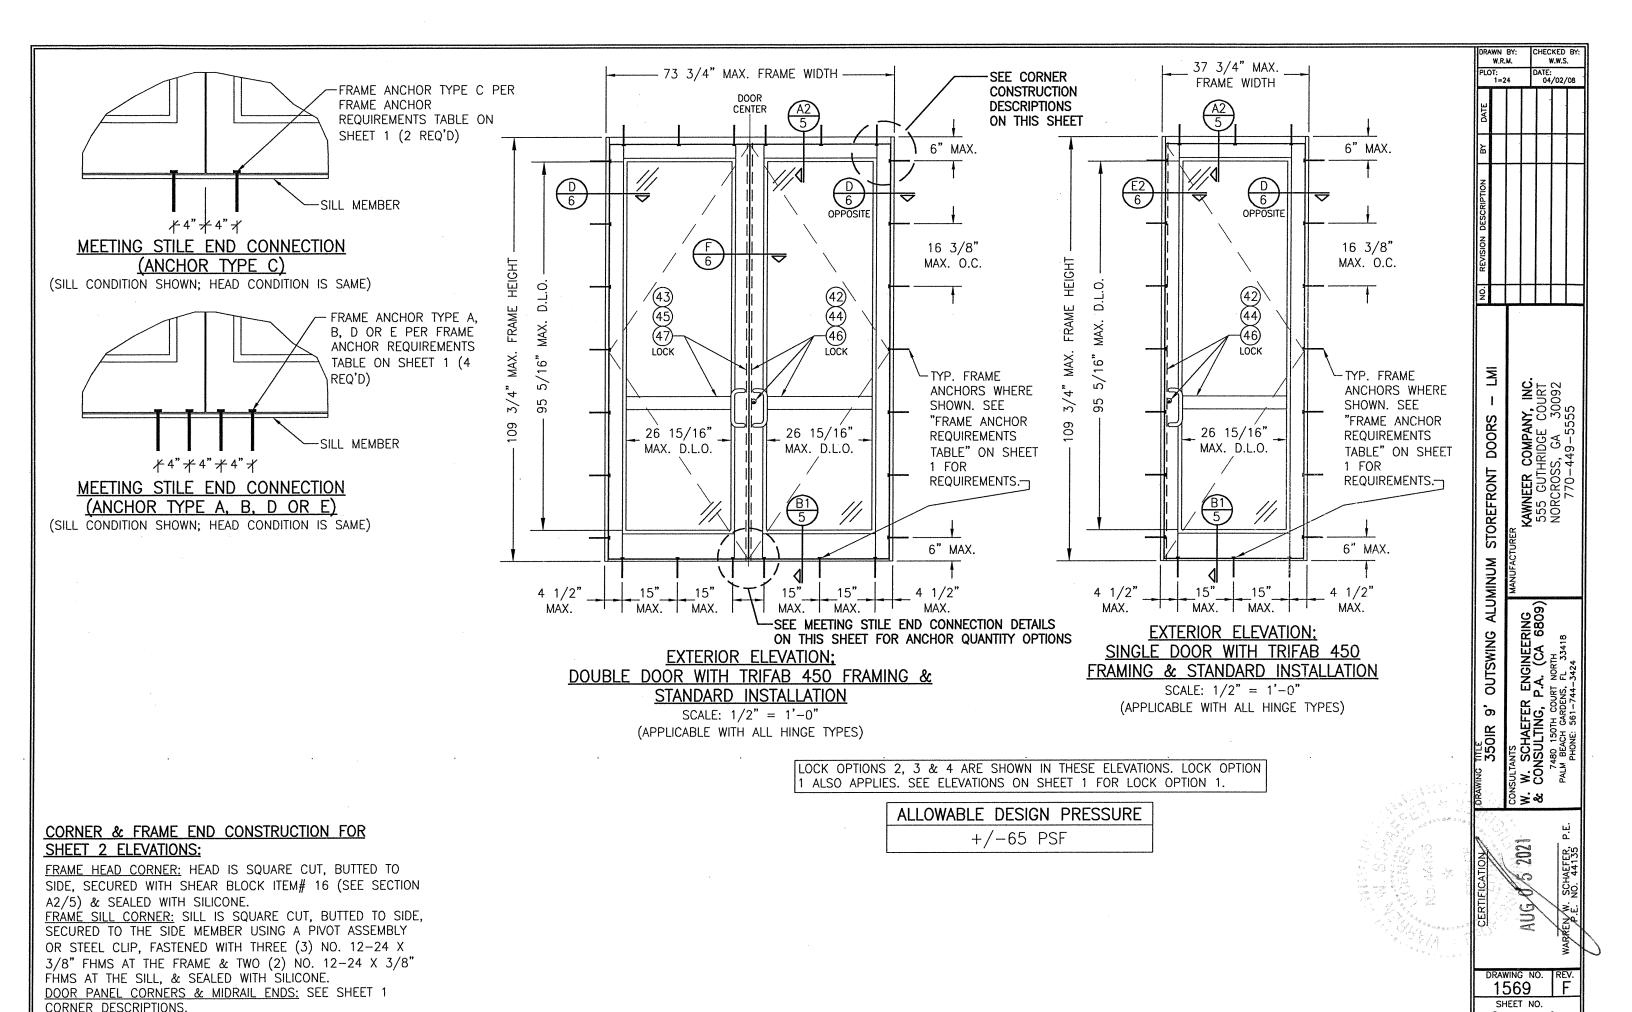
SPECIFIED. THEY MAY NOT BE USED FOR THE ASSEMBLY AND/OR INSTALLATION OF ANY OTHER PRODUCT NOR MAY THEY BE USED FOR RATIONAL AND/OR LOCAL APPROVAL OF ANY PRODUCT NOT PRODUCED BY THE MANUFACTURER

#### 1569 SHEET NO. OF


## FRAME ANCHOR REQUIREMENTS TABLE

|                | FRAME SHEAR SCREWS                                       |   |                  |                       |  |
|----------------|--|---|------------------|-----------------------|--|
| ANCHOR<br>TYPE | OPENING TYPE<br>(SUBSTRATE)                              | FRAME/CLIP/NAIL FIN TO<br>OPENING FASTENER TYPE | MINIMUM<br>EMBED | MINIMUM<br>EDGE DIST. |  |
| Α              | (4) MIN. 2X6 WOOD FRAME OR BUCK<br>(MIN. GR. 3 & G=0.55) | NO. 12 SMS OR WOOD SCREW                        | 1 1/4"           | 3/4"                  |  |
| В              | MIN. 18 GA. 33 KSI METAL STUD                            | (2) NO. 12 GR. 5 SELF TAP/DRILLING SCREW        | FULL             | 1/2"                  |  |
| С              | MIN. 0.22" THICK A36 STEEL                               | (2) 1/4-14 SELF DRILL/TAPPING SCREW             | FULL             | 1/2"                  |  |
| D              | MIN. 0.1" THK 6063-T6 ALUM.<br>/CURTAIN WALL             | (2) 1/4-14 SELF DRILL/TAPPING SCREW             | FULL             | 1/2"                  |  |
| Ε              | (3) C-90 CMU/3000 PSI CONCRETE                           | (1) 1/4" CONCRETE SCREW                         | 1 3/4"           | 2"                    |  |

- (1) CONCRETE SCREWS SHALL BE ELCO ULTRACONS (C.S.), ELCO CRETE-FLEX (S.S.), ITW RAMSET/RED HEAD TAPCONS (C.S. OR S.S.) OR HILTI KWIK-CON II (C.S OR S.S.).
- (2) SELF DRILLING & SELF TAPPING SCREWS SHALL BE MIN. GRADE 5 CORRISION RESISTANT STEEL
- (3) C-90 CMU IS ONLY APPLICABLE AT SIDES OF DOOR OPENING (NOT APPLICABLE TO HEAD & SILL) (4) WOOD FRAME OR BUCK MEMBERS MAY BE RIPPED DOWN TO A MINIMUM 4 1/2" DEPTH.



OF

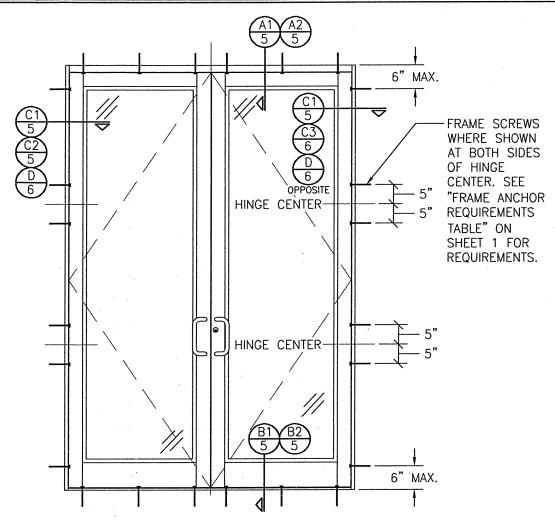

# EXTERIOR ELEVATION; DOUBLE DOOR WITH ALTERNATE INSTALLATION CONDITION

SCALE: 1/2" = 1'-0"


(APPLICABLE WITH BUTT & PIVOT HINGE DOORS ONLY)

(FOR DOOR DETAIL & HARDWARE NOT SHOWN, SEE

ELEVATIONS ON SHEETS 1 & 2)

(ELEVATION SHOWN WITH TRIFAB 450 FRAMING.

IR-500/501 FRAMING ALSO APPLIES)

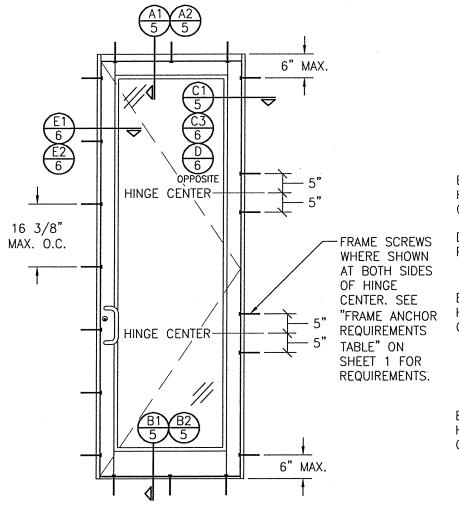

# EXTERIOR ELEVATION; SINGLE DOOR WITH ALTERNATE INSTALLATION CONDITION

SCALE: 1/2" = 1'-0"


(APPLICABLE WITH BUTT & PIVOT HINGE DOORS ONLY)

(FOR DOOR DETAIL & HARDWARE NOT SHOWN, SEE

ELEVATIONS ON SHEETS 1 & 2)

(ELEVATION SHOWN WITH TRIFAB 450 FRAMING.

IR-500/501 FRAMING ALSO APPLIES)

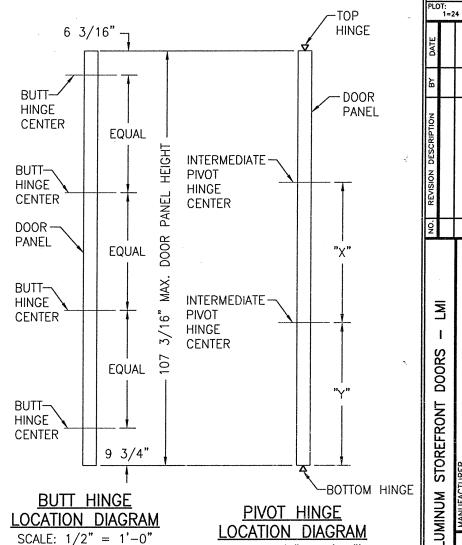

SCALE: 1/2" = 1'-0"

"X" = DOOR PANEL

"Y" = "X" + 3/4"

HEIGHT/2 - 17 3/8)

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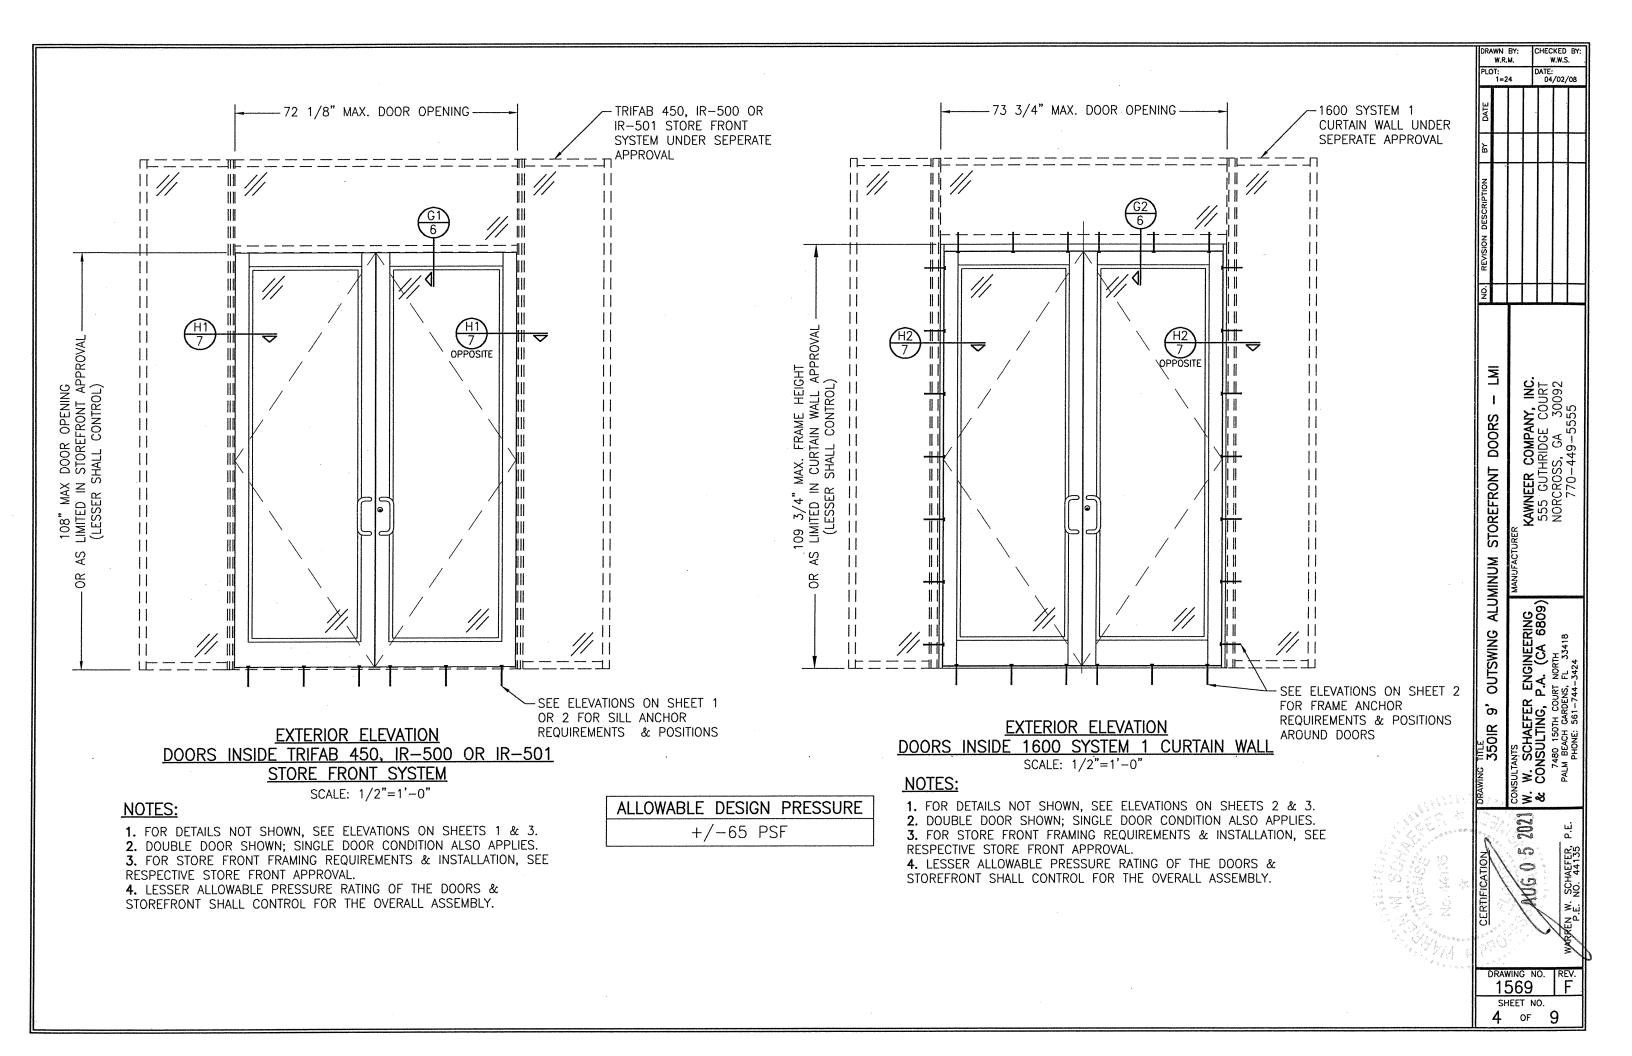
KAWNEER COMPANY, INC. 555 GUTHRIDGE COURT NORCROSS, GA 30092 770-449-5555


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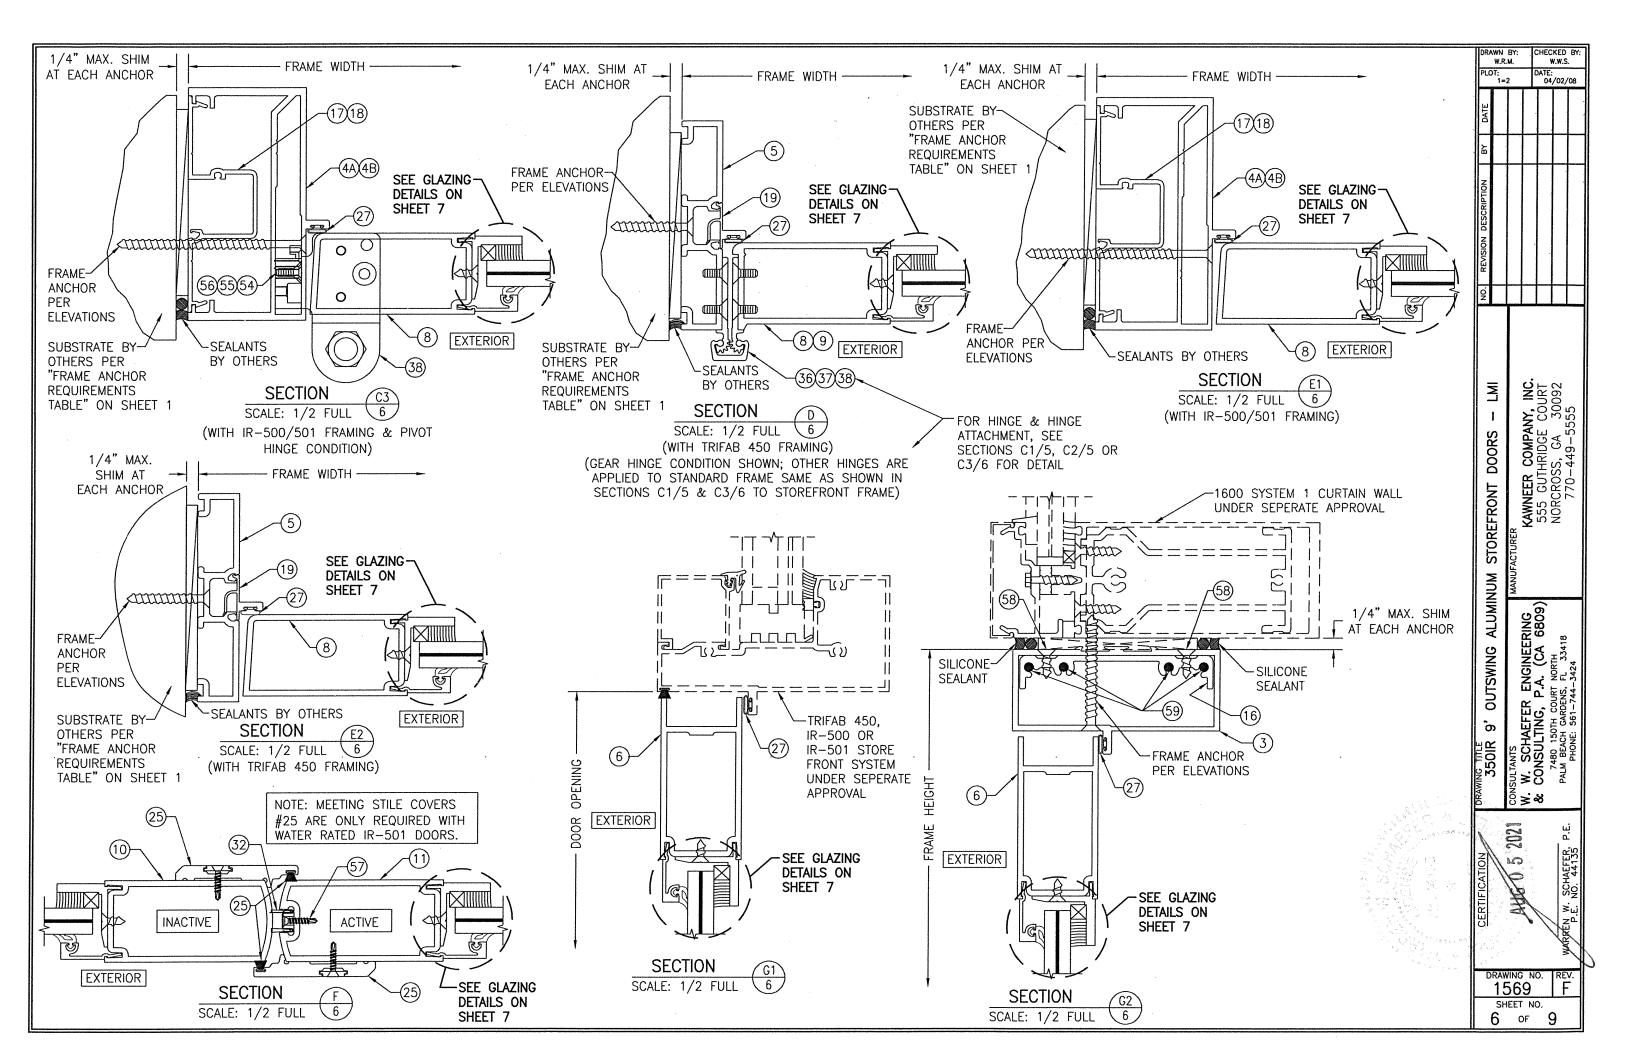
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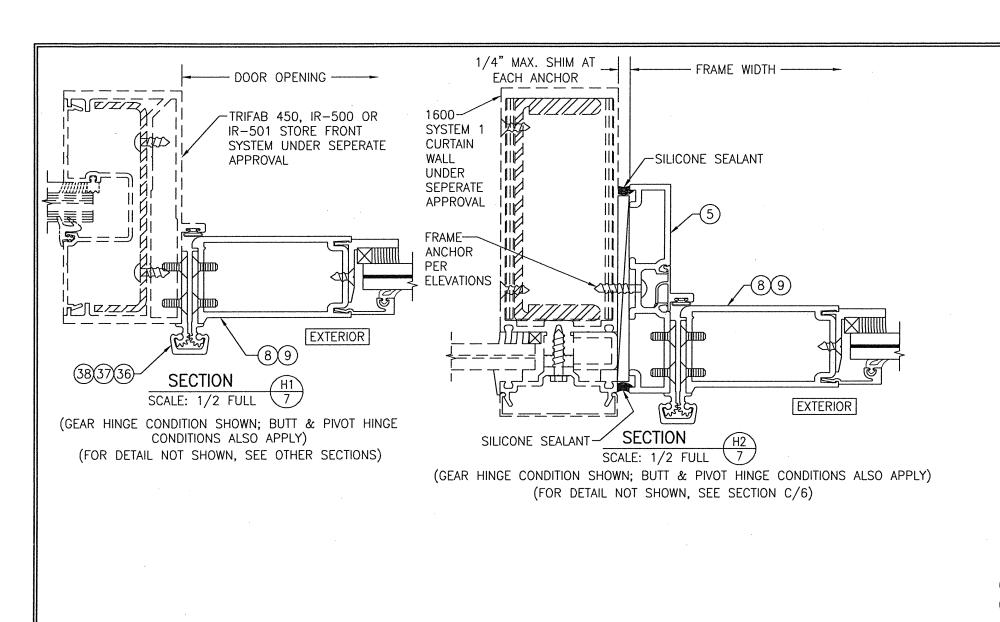
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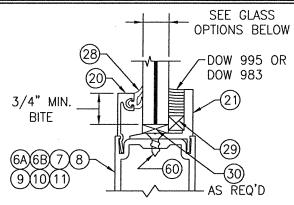
3 OF










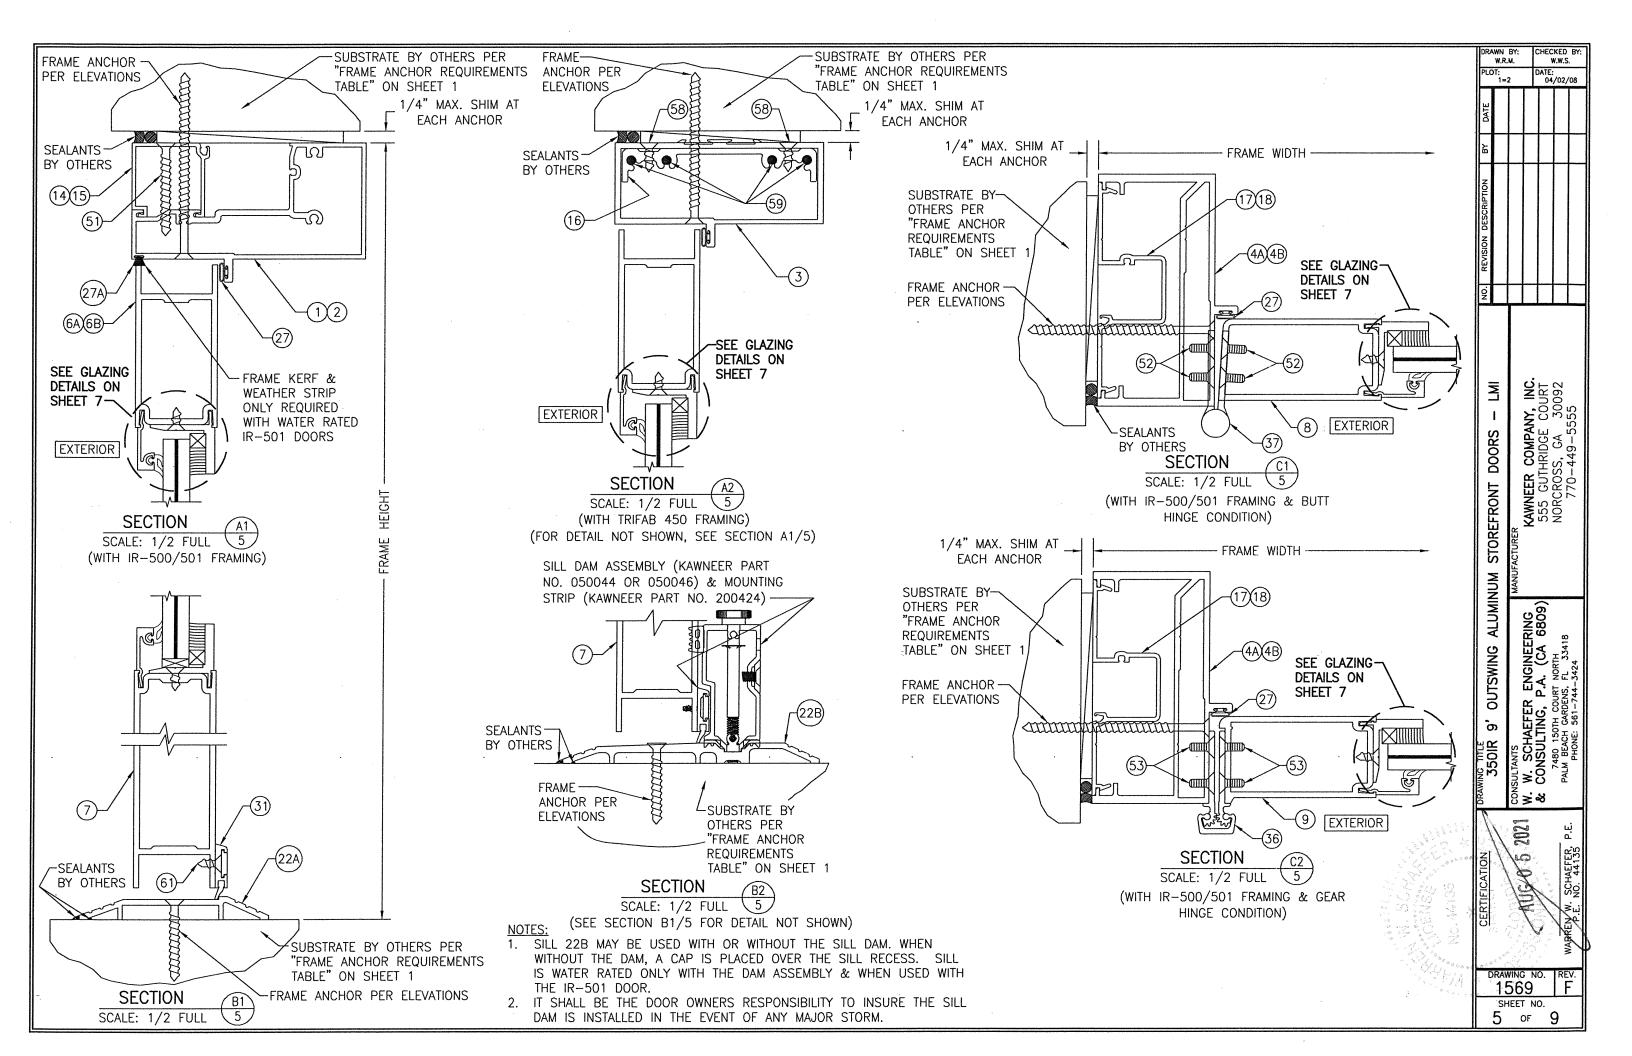

# TYP. MONOLITHIC GLAZING DETAIL

#### GLASS OPTIONS FOR MONOLITHIC GLASS:

OPTION 1: 9/16" THICK LAMINATED GLASS (1/4" HT. ST./0.100 EASTMAN CHEMICAL CO. SAFLEX/1/4" HT. ST.)
OPTION 2: 9/16" THICK LAMINATED GLASS (1/4" HT. ST./0.090 EASTMAN CHEMICAL CO. SAFLEX/1/4" HT. ST.)

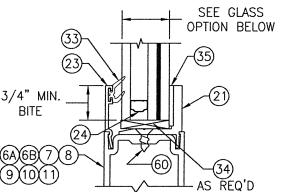

# TYP. I.G. GLAZING DETAIL

#### **GLASS OPTIONS FOR IG GLASS:**


OPTION 3: 1" THICK I.G LAMINATED GLASS (3/16" TEMP EXTERIOR; 3/8" AIR SPACE; 3/16" HT. ST./0.090" KURARAY (PREVIOUSLY DUPONT) SG/3/16" HT. ST. INTERIOR)

| NO. REVISION DESCRIPTION BY DATE          |   |              |                            |                             |   |                     |
|---|---|--------------|----------------------------|-----------------------------|---|---------------------|
| M. Sacoa Fragandacto M.                   | SOUR S COLOMING ALUMINUM SICHEFRUNI DOURS - LMI | MANUFACTURER | KAWNEER COMPANY, INC.      | 555 GUTHRIDGE COURT         | NORCROSS, GA 30092                                  | //0-449-5555        |
| DRAWING TITLE ZEOID O' OLITEMINIO ALLIMIN | SOUR & COLOWING ALUMIN                          | CONSULTANTS  | W. W. SCHAEFER ENGINEERING | & CONSULING, P.A. (CA 6809) | 7480 150TH COURT NORTH PALM BEACH GARDENS, FL 33418 | PHONE: 561-744-3424 |
| <u>CERTIFICATION</u>                      |   |              | 1505 W                     |                             | DOCK W COUNTRY                                      | P.E. NO. 44135      |

1569 SHEET NO. 7 OF

CHECKED BY: W.W.S.

> DATE: 04/02/08

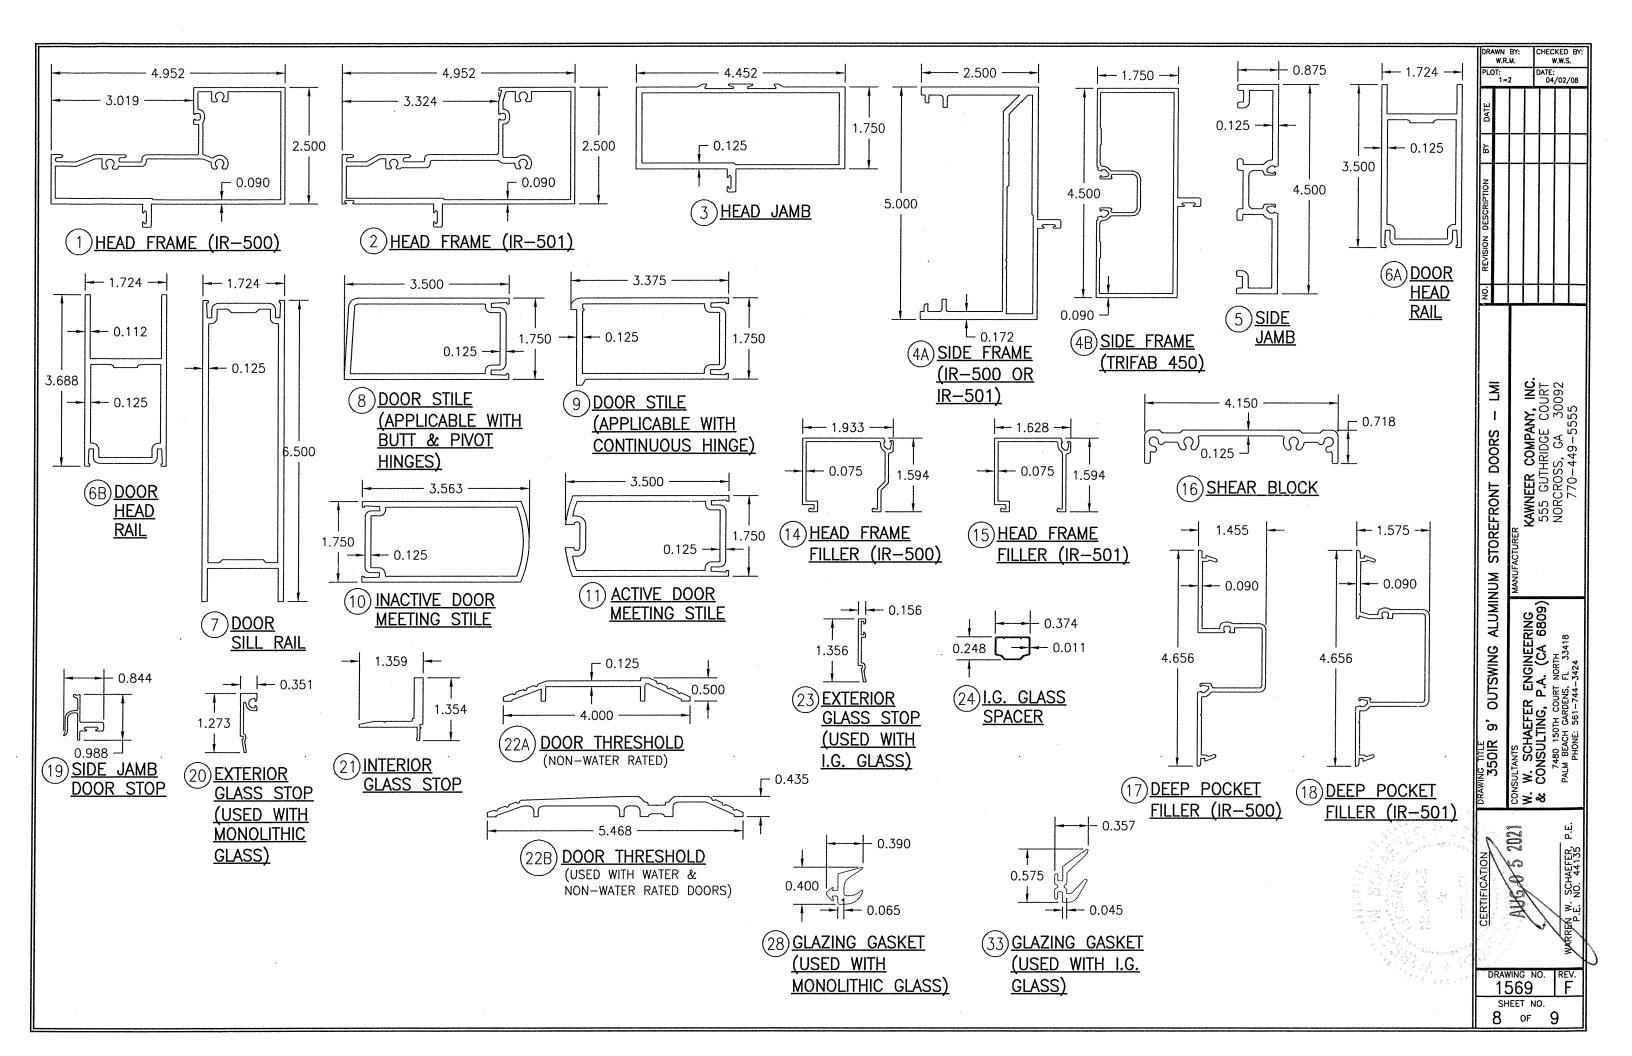

| ITEM #   | PART #      | ITEM DESCRIPTION                                 | MANUFACTURER/NOTES             |
|----------|-------------|--|--------------------------------|
|          |             | PARTS  |                                |
| 1        | 575-022     | HEAD FRAME (IR-500)                              | 6063-T6 ALUMINUM               |
| 2        |             | HEAD FRAME (IR-501)                              | 6063-T6 ALUMINUM               |
| 3        |             | HEAD JAMB  | 6063-T6 ALUMINUM               |
| 4A       |             | SIDE FRAME (IR 500-OR IR-501)                    | 6063-T6 ALUMINUM               |
| 4B       |             | SIDE FRAME (TRIFAB 450)                          | 6063-T6 ALUMINUM               |
| 5        |             | SIDE FRAME (1600 DR JB ADAPTOR)                  | 6063-T6 ALUMINUM               |
| 6A       |             | DOOR; TOP RAIL                                   | 6063-T6 ALUMINUM               |
| 6B       |             | DOOR; TOP RAIL                                   | 6063-T6 ALUMINUM               |
| 7        |             |  | 6063-T6 ALUMINUM               |
| 8        |             | DOOR; BOTTOM RAIL                                | 6063-T6 ALUMINUM               |
| 8        | 200-005     | DOOR STILE (APPLICABLE WITH BUTT                 | 6063-16 ALUMINUM               |
| <u> </u> | 222 242     | & PIVOT HINGES)                                  | COCZ TC ALLBANDA               |
| 9        | 200-012     | DOOR STILE (APPLICABLE WITH                      | 6063-T6 ALUMINUM               |
|          |             | CONTINUOUS HINGES)                               | 2027 70 1111 1111              |
| 10       |             | INACTIVE DOOR MEETING STILE                      | 6063-T6 ALUMINUM               |
| 11       |             | ACTIVE DOOR MEETING STILE                        | 6063-T6 ALUMINUM               |
| 14       |             | HEAD FRAME FILLER (IR-500)                       | 6063-T6 ALUMINUM               |
| 15       |             | HEAD FRAME FILLER (IR-501)                       | 6063-T6 ALUMINUM               |
| 16       |             | SHEAR BLOCK                                      | 6063-T6 ALUMINUM               |
| 17       | 575-035     | DEEP POCKET FILLER (IR-500)                      | 6063-T6 ALUMINUM               |
| 18       | 575-135     | DEEP POCKET FILLER (IR-501)                      | 6063-T6 ALUMINUM               |
| 19       |             | SIDE JAMB DOOR STOP                              | 6063-T6 ALUMINUM               |
| 20       | 575-043     | EXTERIOR GLASS STOP (USED WITH                   | 6063-T6 ALUMINUM               |
|          |             | MONOLITHIC GLASS)                                |                                |
| 21       | 575-045     | INTERIOR GLASS STOP                              | 6063-T6 ALUMINUM               |
| 22A      | 069-139     | DOOR THRESHOLD (NON-WATER RESISTANCE RATED)      | 6063-T6 ALUMINUM               |
| 22B      |             | DOOR THRESHOLD (WATER RESISTANCE RATED WITH DAM) | 6063-T6 ALUMINUM               |
| 23       |             | EXTERIOR GLASS STOP (USED WITH                   | 6063-T6 ALUMINUM               |
|          |             | I.G. GLASS)                                      |                                |
| 24       | _           | I.G. GLASS SPACER                                | 3005 OR 3105 ALUMINUM          |
| 25       | <del></del> | CO9 MEETING STILE COVER FOR WATER RATED DOOR     | MATERIAL VARIES                |
|          | 1000        | SEALS AND SEALANTS                               |                                |
| 27       | 027-078     |  | ALCRYN                         |
| 27A      |             | .210 PILE WEATHERSTRIP                           | PVC UNPLASTICIZED              |
| 28       |             | GLAZING GASKET (USED WITH MONOLITHIC GLASS)      |                                |
| 20       | 027-303     | GEAZING GASKET (OSED WITH MONOEITHE GEASS)       | DUROMETER 70 +/-5              |
| 20       | 127 041     | GLAZING TAPE / SILICONE SPACER                   | SEMI-RIGID POLYURETHANE FOAM   |
| 29       |             |  | NEOPRENE                       |
| 30       | ļ           | SETTING BLOCK (USED WITH MONOLITHIC GLASS)       |                                |
| 31       | <u> </u>    | DOOR BOTTOM RAIL WEATHER SWEEP                   | VARIED                         |
|          | <del></del> | ADJUSTABLE ASTRAGAL WEATHERING                   | VARIED                         |
| 33       | 02/-557     | GLAZING GASKET (USED WITH I.G. GLASS)            | KRP 027-557 POLYPROPYLENE &    |
|          |             |  | SANTOPRENE DUROMETER 65 +/-5   |
| 34       | <del></del> | SETTING BLOCK (USED WITH I.G. GLASS)             | NEOPRENE                       |
| 35       | [200-948]   | GLAZING TAPE (USED WITH I.G. GLASS)              | 3M VHB                         |
|          | ,           | HARDWARE   |                                |
| 36       |             | CONTINUOUS GEAR HINGE                            | BY HAGER/ROTON, STANLEY OR ABH |
| 37       | 037-264     | BUTT HINGE                                       | BY HAGER, STANLEY OR MCKINNEY  |
| 38       | 050-322     | TOP OFFSET PIVOT HINGE                           | BY KAWNEER                     |
|          | 050-331     | INTERMEDIATE OFFSET PIVOT HINGE                  |                                |
|          | <u></u>     | RH BOTTOM OFFSET PIVOT HINGE                     |                                |
|          |             | LH BOTTOM OFFSET PIVOT HINGE                     |                                |
|          |             |  |                                |

| ITEM # | PART #   | ITEM DESCRIPTION                                       | MANUFACTURER/NOTES             |
|--------|--|--|--------------------------------|
|        | American management and a second | HARDWARE   |                                |
| 39     | 3-POINT  | LOCK ASSEMBLY FOR ACTIVE DOOR                          | ADAMS-RITE 1850                |
|        |  | (APPLICALE AS PART OF LOCK OPTION 1)                   |                                |
|        | 50-075   | BOLT GUIDE   |                                |
|        | 50-078   | TOP BOLT   | 1                              |
|        | 50-100   | DEADLOCK   |                                |
|        | 37-368   | BOTTOM BOLT  |                                |
|        | 35-001   | CYLINDER   | BY KAWNEER                     |
|        | 37-176   | THUMBTURN  |                                |
|        | 137-700  | CO-9 PUSH / CP-II PUSH                                 |                                |
|        |  | PACKAGE  |                                |
| 40     | 50-079   | INACTIVE DOOR TOP FLUSH BOLT                           | ADAMS-RITE 1850                |
|        |  | (APPLICALE AS PART OF LOCK OPTION 1)                   |                                |
| 41     | 50-075   | INACTIVE DOOR BOTTOM FLUSH BOLT                        | ADAMS-RITE 1850                |
| •      |  | (APPLICALE AS PART OF LOCK OPTION 1)                   |                                |
| 42     | -  | LOCK ASSEMBLY/CVR PANIC DEVICE FOR ACTIVE              | VON DUPRIN HH9947              |
|        |  | DOOR (APPLICALE AS PART OF LOCK OPTION 2)              |                                |
|        |  | DEADBOLT/CYLINDER                                      | SCHLAGE 037304                 |
| 43     |  | LOCK ASSEMBLY/PANIC DEVICE FOR INACTIVE DOOR           | VON DUPRIN HH9947              |
|        |  | (APPLICALE AS PART OF LOCK OPTION 2)                   |                                |
| 44     |  | LOCK ASSEMBLY/CVR PANIC DEVICE FOR ACTIVE              | FALCON HH1690                  |
|        |  | DOOR (APPLICALE AS PART OF LOCK OPTION 3)              |                                |
|        |  | DEADBOLT/CYLINDER                                      | SCHLAGE 037304                 |
| 45     |  | LOCK ASSEMBLY/PANIC DEVICE FOR INACTIVE DOOR           | FALCON HH1690                  |
| .0     |  | (APPLICALE AS PART OF LOCK OPTION 3)                   |                                |
| 46     |  | LOCK ASSEMBLY/CVR PANIC DEVICE FOR ACTIVE              | KAWNEER 1686                   |
|        |  | DOOR (APPLICALE AS PART OF LOCK OPTION 4)              |                                |
|        |  | DEADBOLT/CYLINDER                                      | SCHLAGE 037304                 |
| 47     |  | LOCK ASSEMBLY/PANIC DEVICE FOR INACTIVE DOOR           | KAWNEER 1686                   |
| 47     |  | (APPLICALE AS PART OF LOCK OPTION 4)                   | I NAMINEEN 1000                |
|        |  | MISCELLANEOUS FASTENERS                                | <u>.</u>                       |
| 51     |  | NO. 12 X 2" SCREW                                      | 3" FROM ENDS & MAX. 11" O.C.   |
| 52     | _  | NO. 12-24 X 9/16" S.S SCREW                            | 8 PER HINGE                    |
| 53     |  | NO. 12-24 X 13/32" SCREW                               | 2 9/16" FROM ENDS & MAX.       |
| 55     |  | 110. 12 21 % 10/02 GONEH                               | 5 1/8" O.C. (52 MAX. PER HING  |
| 54     |  | 5/16"-18 X 5/8" SCREW                                  | 2 PER TOP PIVOT HINGE          |
| 55     |  | NO. 12-24 X 9/16" S.S SCREW                            | 2 PER INTERMEDIATE PIVOT HINGE |
| 56     |  | 1/4-20 X 3/8" SCREW                                    | 3 PER BOTTOM PIVOT HINGE       |
| 57     |  | NO. 6 X 11/16" SCREW                                   | 10 PER LEAF                    |
| 58     |  | NO. 10 X 9/16" S.S SCREW                               | 2 PER CLIP                     |
| 59     |  | NO. 10 X 9/10 3.3 3CREW<br>NO. 10 X 1 9/32" S.S. SCREW | 4 PER CLIP                     |
| 60     |  | NO. 10 X 1 9/32 S.S. SCREW                             | 3" FROM ENDS & MAX. 7 1/2"     |
| 00     | _  | 110. 10 A 1/2 3.3. JUILW                               | O.C. AT TOP & BOTTOM RAILS -   |
|        |  |  | 3" FROM ENDS & MAX. 11 1/8"    |
|        |  |  | O.C. AT STILES                 |
| 61     |  | NO. 6 X 3/8" S.S. SCREW                                | 1/4" FROM ENDS & MAX.          |
| 01     | -  | NO. U A J/U 3.3. 301/LW                                | 9 17/32" O.C.                  |
| 1      |  |  | 13 17/32 0.0.                  |

DRAWN BY: W.R.M. CHECKED BY: W.W.S. DATE: 04/02/08 CONSULTANTS

W. W. SCHAEFER ENGINEERING
& CONSULTING, P.A. (CA 6809)

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W. W. SCHAEFER ENGINEERING
& CONSULTING, P.A. (CA 6809)

A 7480 1501 COURT

PAUM BEACH COURT

PALM BEACH GARDENS, FL 33418

PHONE: 561-744-3424 WARREN W. SCHAEFER, P.E. AUG O BESTART DRAWING NO. R 1569 SHEET NO. 9 OF 9